



VILLAGE MAYOR: KEVIN HUBER

VILLAGE BOARD MEMBERS: JAMES WILLIAMS  
JOSEPH NICHLAS  
JENNIFER NIZNIK  
MICHAEL RUFFEN  
JOHN TYLISZAK  
JEFF SMITH

VILLAGE ATTORNEY: IAN LINDARS

VILLAGE CLERK: JOHN M. KARGE

VILLAGE SUPERINTENDENT OF PUBLIC WORKS: JOHN NUCULOVIC

- SHEET LIST:
- 1. COVER
  - 2. CONCEPTUAL MASTER PLAN (FOR REFERENCE ONLY)
  - 3. EXISTING CONDITIONS
  - 4. PROPOSED PLAY AREA
  - 5. DETAILS


OWNER'S CERTIFICATION  
I, KEVIN HUBER, THE UNDERSIGNED, MAYOR OF THE  
VILLAGE OF WAPPINGERS FALLS, DO HEREBY STATE  
THAT I HAVE REVIEWED THESE PLANS, THEIR CONTENTS,  
LEGENDS, AND DATA, AM FAMILIAR WITH THE SAME AND  
DO HEREBY CONSENT TO ALL ILLUSTRATIONS, TERMS,  
AND CONDITIONS NOTED HEREON.

KEVIN HUBER  
MAYOR, VILLAGE OF WAPPINGERS FALLS

DATE

VERMA  
ENGINEERING &  
CONSULTING

RAHUL VERMA, P.E.  
HOFEWELL JUNCTION, NEW YORK  
RAHUL@VERMAENGINEERING.COM  
914-924-7816

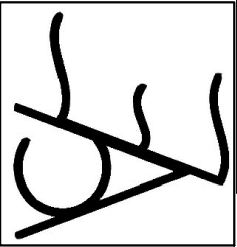

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**BAIN PARK PLAY EQUIPMENT AREA  
COVER**


**BID DOCUMENTS  
COMMUNITY DEVELOPMENT BLOCK GRANT PROJECT**

INTERSECTION OF CLAPP AVENUE AND LOWER HENRY STREET  
TAX PARCEL NUMBER: 135601-6158-17-2 17093-0000

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No.	Date	Revision
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FOR REDUCED PLANS:  
ORIGINAL IN INCHES



PROJECT # 23-1004	SHEET NUMBER
DATE: OCT. 9, 2023	1
SCALE: AS SHOWN	
DRAWN BY: RV	SHEET 1 OF 5

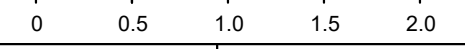








**SURVEY NOTES**

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  5. CERTIFICATIONS ON THIS BOUNDARY SURVEY MAP SIGNIFY THAT THE MAP WAS PREPARED IN ACCORDANCE WITH THE EXISTING CODE OF PRACTICE FOR LAND SURVEYS ADOPTED BY THE NEW YORK STATE ASSOCIATION OF PROFESSIONAL LAND SURVEYORS, INC.
  6. GUARANTEES OR CERTIFICATIONS INDICATED HEREON SHALL RUN ONLY TO THE PERSONS FOR WHOM THE SURVEY IS PREPARED AND ON HIS BEHALF TO THE TITLE COMPANY, GOVERNMENTAL AGENCY, AND THE LENDING INSTITUTION. GUARANTEES OR CERTIFICATIONS ARE NOT TRANSFERABLE TO ADDITIONAL INSTITUTIONS OR SUBSEQUENT OWNERS.
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**BAIN PARK PLAY EQUIPMENT AREA  
EXISTING CONDITIONS**


BID DOCUMENTS  
COMMUNITY DEVELOPMENT BLOCK GRANT PROJECT

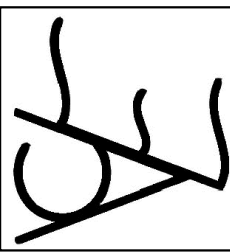INTERSECTION OF CLAPP AVENUE AND LOWER HENRY STREET  
TAX PARCEL NUMBER: 135601-6158-17-217093-0000

NEW YORK

DUTCHESS COUNTY

VILLAGE OF WAPPINGERS FALLS

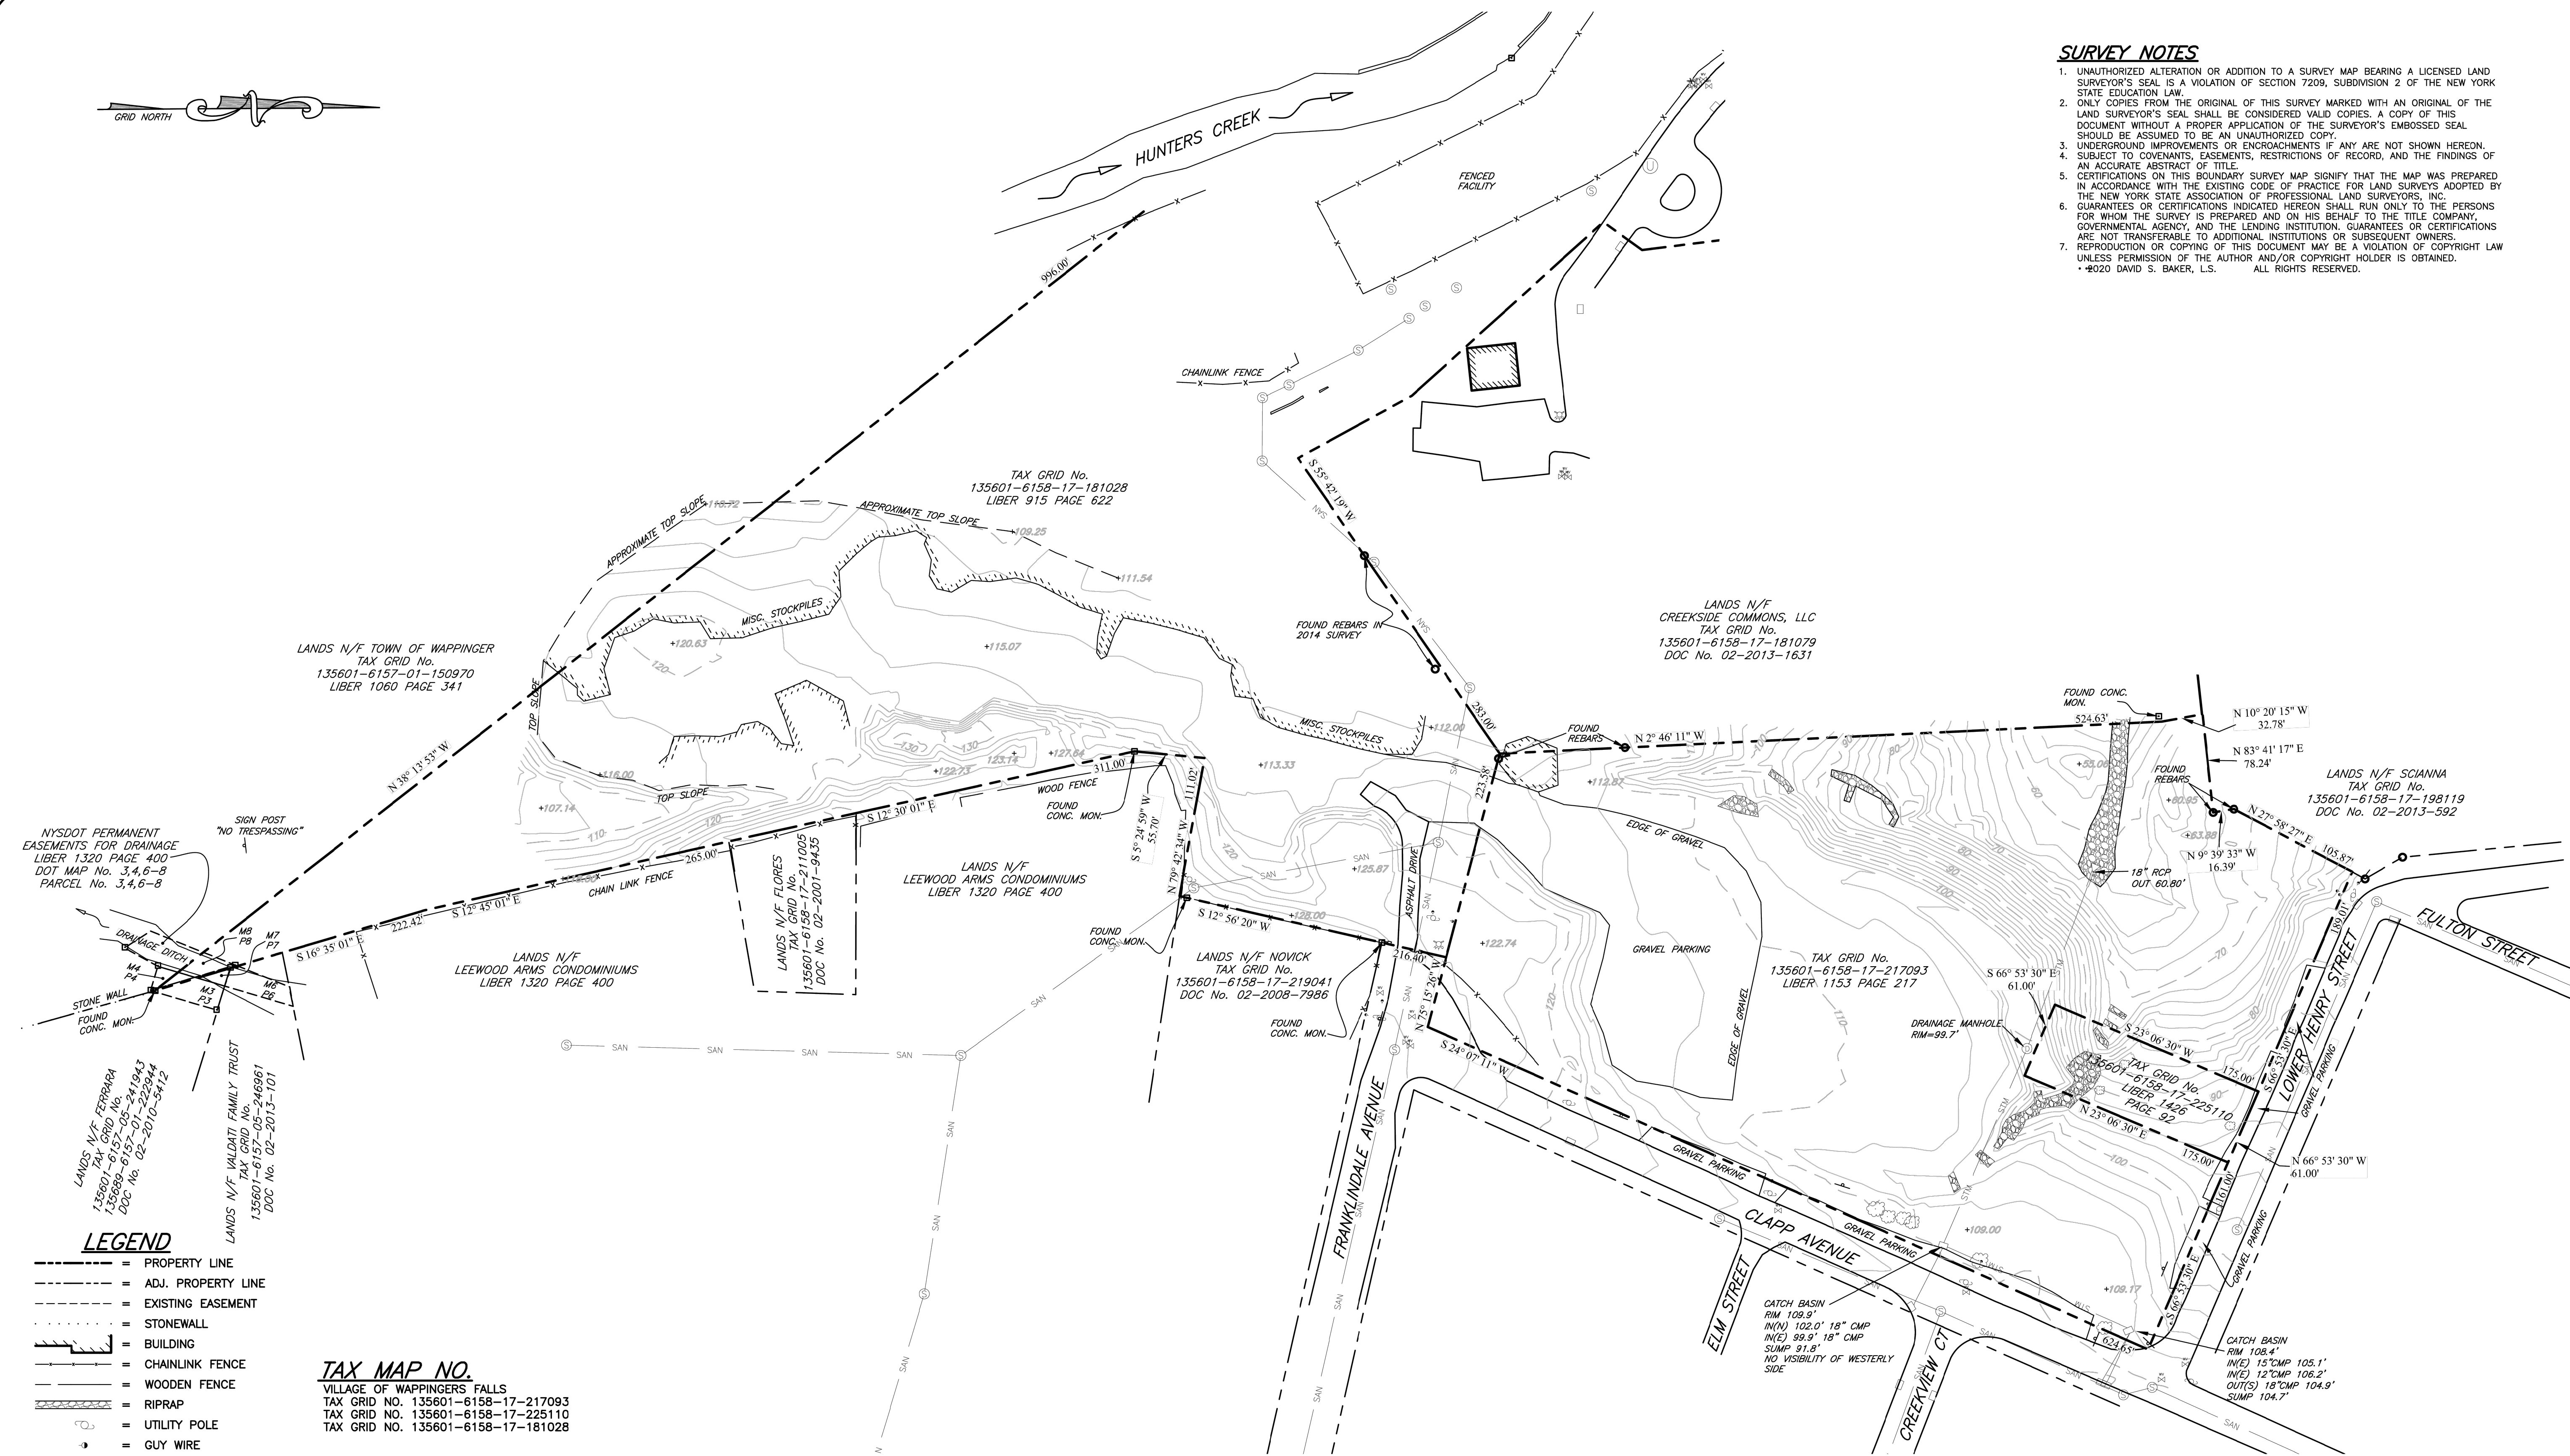

**LEGEND**

- = PROPERTY LINE
- - -= ADJ. PROPERTY LINE
- - -= EXISTING EASEMENT
- - -= STONEWALL
- = BUILDING
- - -= CHAINLINK FENCE
- - -= WOODEN FENCE
- - -= RIPRAP
- - -= UTILITY POLE
- - -= GUY WIRE
- = SEWER MANHOLE
- = SEWER MAIN
- = DRAINAGE MANHOLE
- = DRAINAGE PIPE
- = WATER VALVE
- = HYDRANT
- = CATCH BASIN GRATE
- = SIGN POST
- = CONCRETE MONUMENT
- = IRON PIPE/REBAR

**TAX MAP NO.**

VILLAGE OF WAPPINGERS FALLS  
TAX GRID NO. 135601-6158-17-217093  
TAX GRID NO. 135601-6158-17-225110  
TAX GRID NO. 135601-6158-17-181028

**DEED REFERENCE**

LIBER 1426 PAGE 92  
LIBER 1153 PAGE 217  
LIBER 915 PAGE 622  
LIBER 455 PAGE 377

**MAP REFERENCE**


A MAP ENTITLED "MAP OF LANDS TO BE CONVEYED BY DUTCHESS BLEACHERY INC. TO VILLAGE OF WAPPINGERS FALLS" PREPARED BY H. STANLEY BOND P.E. DATED AUGUST 1941 AND FILED IN THE DUTCHESS COUNTY CLERKS OFFICE AS FILED MAP #1920.

**NOTES**

1. FIELD SURVEY COMPLETED ON MARCH 27, 2020.
2. TOPOGRAPHY IS THE RESULT OF AN ACTUAL FIELD RUN COMPLETED ON MARCH 27, 2020.
3. VERTICAL DATUM IS NAVD 88, OBTAINED BY RTK GPS OBSERVATIONS UTILIZING THE N.Y.S. D.O.T. RTN NETWORK.
4. BASIS OF BEARINGS IS GRID NORTH, NYS STATE PLANE (NAD83) EASTERN ZONE 3101, DETERMINED BY RTK GPS OBSERVATIONS UTILIZING THE NYS DOT RTN NETWORK.

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DATE: 03/17/22		REVISION: REVISIONS PER DC COMMENTS		BY: MK	SHEET NO. 2 OF 6	EXISTING CONDITIONS BOUNDARY AND TOPOGRAPHIC SURVEY FOR BAIN PARK	
04/08/22		FOR BID		MK	SCALE: 1 IN. = 60 FT.	DRAWING NAME: 1200-072_2_Surv	
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					<input checked="" type="radio"/> FOR REVIEW & COMMENT	<input type="radio"/> FOR APPROVAL	
					<input type="radio"/> FOR BID & CONSTRUCTION	<input type="radio"/> RECORD DRAWING	
						VILLAGE OF WAPPINGERS FALLS DUTCHESS COUNTY, NEW YORK	
						15 Governor Drive, Second Floor Newburgh, NY 12550 Phone: (845) 931-2900 E-mail: info@kcepc.com Web: www.kcepc.com	

**K Engineering and  
Land Surveying, P.C.**

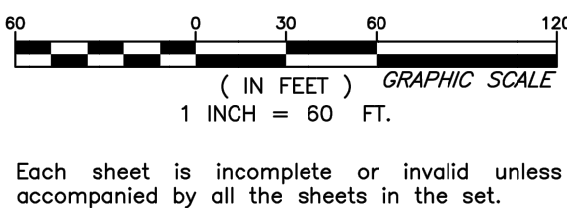EXISTING

FOR REDUCED PLANS:  
ORIGINAL IN INCHES

PROJECT #  
23-1004  
DATE:  
OCT. 9, 2023  
SCALE:  
AS SHOWN  
DRAWN BY:  
RV

SHEET NUMBER  
**3**

SHEET 3 OF 5



## EROSION AND SEDIMENTATION CONTROL NOTES


1. SITE DISTURBANCE SHALL BE LIMITED TO THE MINIMUM NECESSARY GRADING AND VEGETATION REMOVAL REQUIRED FOR CONSTRUCTION.
2. ACTIVE DISTURBANCE SHALL BE LIMITED AS MUCH AS IS PRACTICAL TO CONSTRUCT THE PROPOSED IMPROVEMENTS. ONCE ROUGH GRADING IS COMPLETED THE DISTURBED AREAS SHALL BE STABILIZED IMMEDIATELY.
3. TEMPORARY EROSION CONTROL MEASURES, INCLUDING SILT FENCES AND/OR STRAW BALE DIKES, DRAINAGE STRUCTURES, SEDIMENT TRAPS, SEDIMENTATION BASINS, PERIMETER SWALES/DIKES, AND RIP-RAP PROTECTION SHALL BE INSTALLED PRIOR TO GROUND DISTURBANCE FOR GRADING AND CONSTRUCTION.
4. PRACTICAL FOLLOWING DISTURBANCE TO STABILIZE BARE SOIL AND PROMOTE THE PROMPT RE-ESTABLISHMENT OF VEGETATION:
  - A. AN ADEQUATE SEEDBED SHALL BE PREPARED BY SCARIFYING COMPACTED SOIL AND REMOVING SURFACE DEBRIS AND OBSTACLES.
  - B. LIME SHALL BE APPLIED SUFFICIENTLY TO ATTAIN A SOIL ACIDITY PH OF 6.0 TO 7.0.
  - C. FERTILIZER (5-10-10 MIXTURE OR EQUIVALENT) SHALL BE APPLIED PER SOIL TEST RESULTS OR AT A RATE OF 600 LBS. PER ACRE.
  - D. DISTURBED AREAS WHICH WILL REMAIN TEMPORARILY FALLOW FOR PERIODS GREATER THAN 14 DAYS SHALL BE SEEDDED AT THE FOLLOWING RATE TO PRODUCE TEMPORARY GROUND COVER: 30 LBS. RYEGRASS (ANNUAL OR PERENNIAL) PER ACRE. DURING THE WINTER, USE 100 LBS. CERTIFIED "AROOSTOOK" WINTER RYE (CEREAL RYE) PER ACRE.
  - E. PERMANENT SEEDING SHALL BE APPLIED ON 6" MIN TOPSOIL AT THE FOLLOWING RATE FOR ROUGH OR OCCASIONAL MOWING AREAS:
    - 8 LBS EMPIRE BIRDSFOOT TREFLOIL OR COMMON WHITE CLOVER PER ACRE PLUS
    - 20 LBS TALL FESCUE PER ACRE PLUS
    - 2 LBS REDTOP OR 5 LBS RYEGRASS (PERENNIAL) PER ACRE
  - FOR MOWED AREAS:
    - 65 LBS KENTUCKY BLUEGRASS PER ACRE
    - 65 LBS RYEGRASS (PERENNIAL) PER ACRE
  - F. ALL SEEDING SHALL BE PERFORMED USING THE BROADCAST METHOD OR HYDROSEEDING, UNLESS OTHERWISE APPROVED.
  - G. ALL DISTURBED AREAS SHALL BE STABILIZED SUBSEQUENT TO SEEDING BY APPLYING 2 TONS OF STRAW MULCH PER ACRE. STRAW MULCH SHALL BE ANCHORED BY APPLYING 750 LBS OF WOOD FIBER MULCH PER ACRE WITH A HYDROSEEDER, OR TUCKING THE MULCH WITH SMOOTH DISCS OR OTHER MULCH ANCHORING TOOLS TO A DEPTH OF 3". MULCH ANCHORING TOOLS SHALL BE PULLED ACROSS SLOPES ALONG TOPOGRAPHIC CONTOURS.
5. ALL EROSION AND SEDIMENTATION CONTROL MEASURES AND DRAINAGE STRUCTURES SHALL BE INSPECTED DAILY BY THE CONTRACTOR, AND MAINTENANCE AND REPAIRS SHALL BE PERFORMED PROMPTLY TO MAINTAIN PROPER FUNCTION. TRAPPED SEDIMENT SHALL BE REMOVED AND DEPOSITED IN A PROTECTED AREA IN A PROPER MANNER WHICH WILL NOT RESULT IN EROSION.
6. TEMPORARY CONTROL MEASURES SHALL REMAIN IN PLACE UNTIL DISTURBED AREAS ARE PERMANENTLY STABILIZED AND GROUND COVER IS COMPLETELY REESTABLISHED. FOLLOWING STABILIZATION, TEMPORARY MEASURES SHALL BE REMOVED TO AVOID INTERFERENCE WITH DRAINAGE.
7. ALL STORM INLETS TO BE PROTECTED FROM SEDIMENTATION DURING CONSTRUCTION.
8. SYNTHETIC OR ORGANIC SOIL STABILIZERS MAY BE USED UNDER SUITABLE CONDITIONS AND IN SUFFICIENT QUANTITIES.
9. MULCH NETTING SUCH AS PAPER, JUTE, EXCELSIOR, COTTON OR PLASTIC MAY BE USED. STAPLE IN PLACE. OVER HAY OR STRAW MULCH. USE A DEGRADABLE NETTING IN AREAS TO BE MOWED.
10. STABILIZATION OF STEEP SLOPES SHALL BE ACHIEVED BY APPLYING LIME AND FERTILIZER AS SPECIFIED ABOVE AND SEEDING WITH THE FOLLOWING MIXTURE:

MATERIAL	LBS./ACRE
PERENNIAL RYE GRASS	30
CROWN VETCH	12
SPREADING FESCUE	25
11. OPTIMUM SEEDING PERIODS ARE FROM MARCH 15 TO MAY 15 AND/OR FROM AUGUST 15 TO OCTOBER 15.

### LEGEND


- PROPERTY BOUNDARY  
 --- EXISTING 10 FT. CONTOUR  
 --- EXISTING 2 FT. CONTOUR  
 7.2 X EXISTING SPOT ELEVATION  
 --- EXISTING PAVING  
 ——— EXISTING BUILDING

- PROPOSED 10 FT. CONTOUR  
PROPOSED 2 FT. CONTOUR  
PROPOSED SPOT ELEVATION  
PROPOSED LIMIT OF DISTURBANCE  
PROPOSED EDGE OF ASPHALT  
PROPOSED ASPHALT PAVING  
PROPOSED CONCRETE PAVING

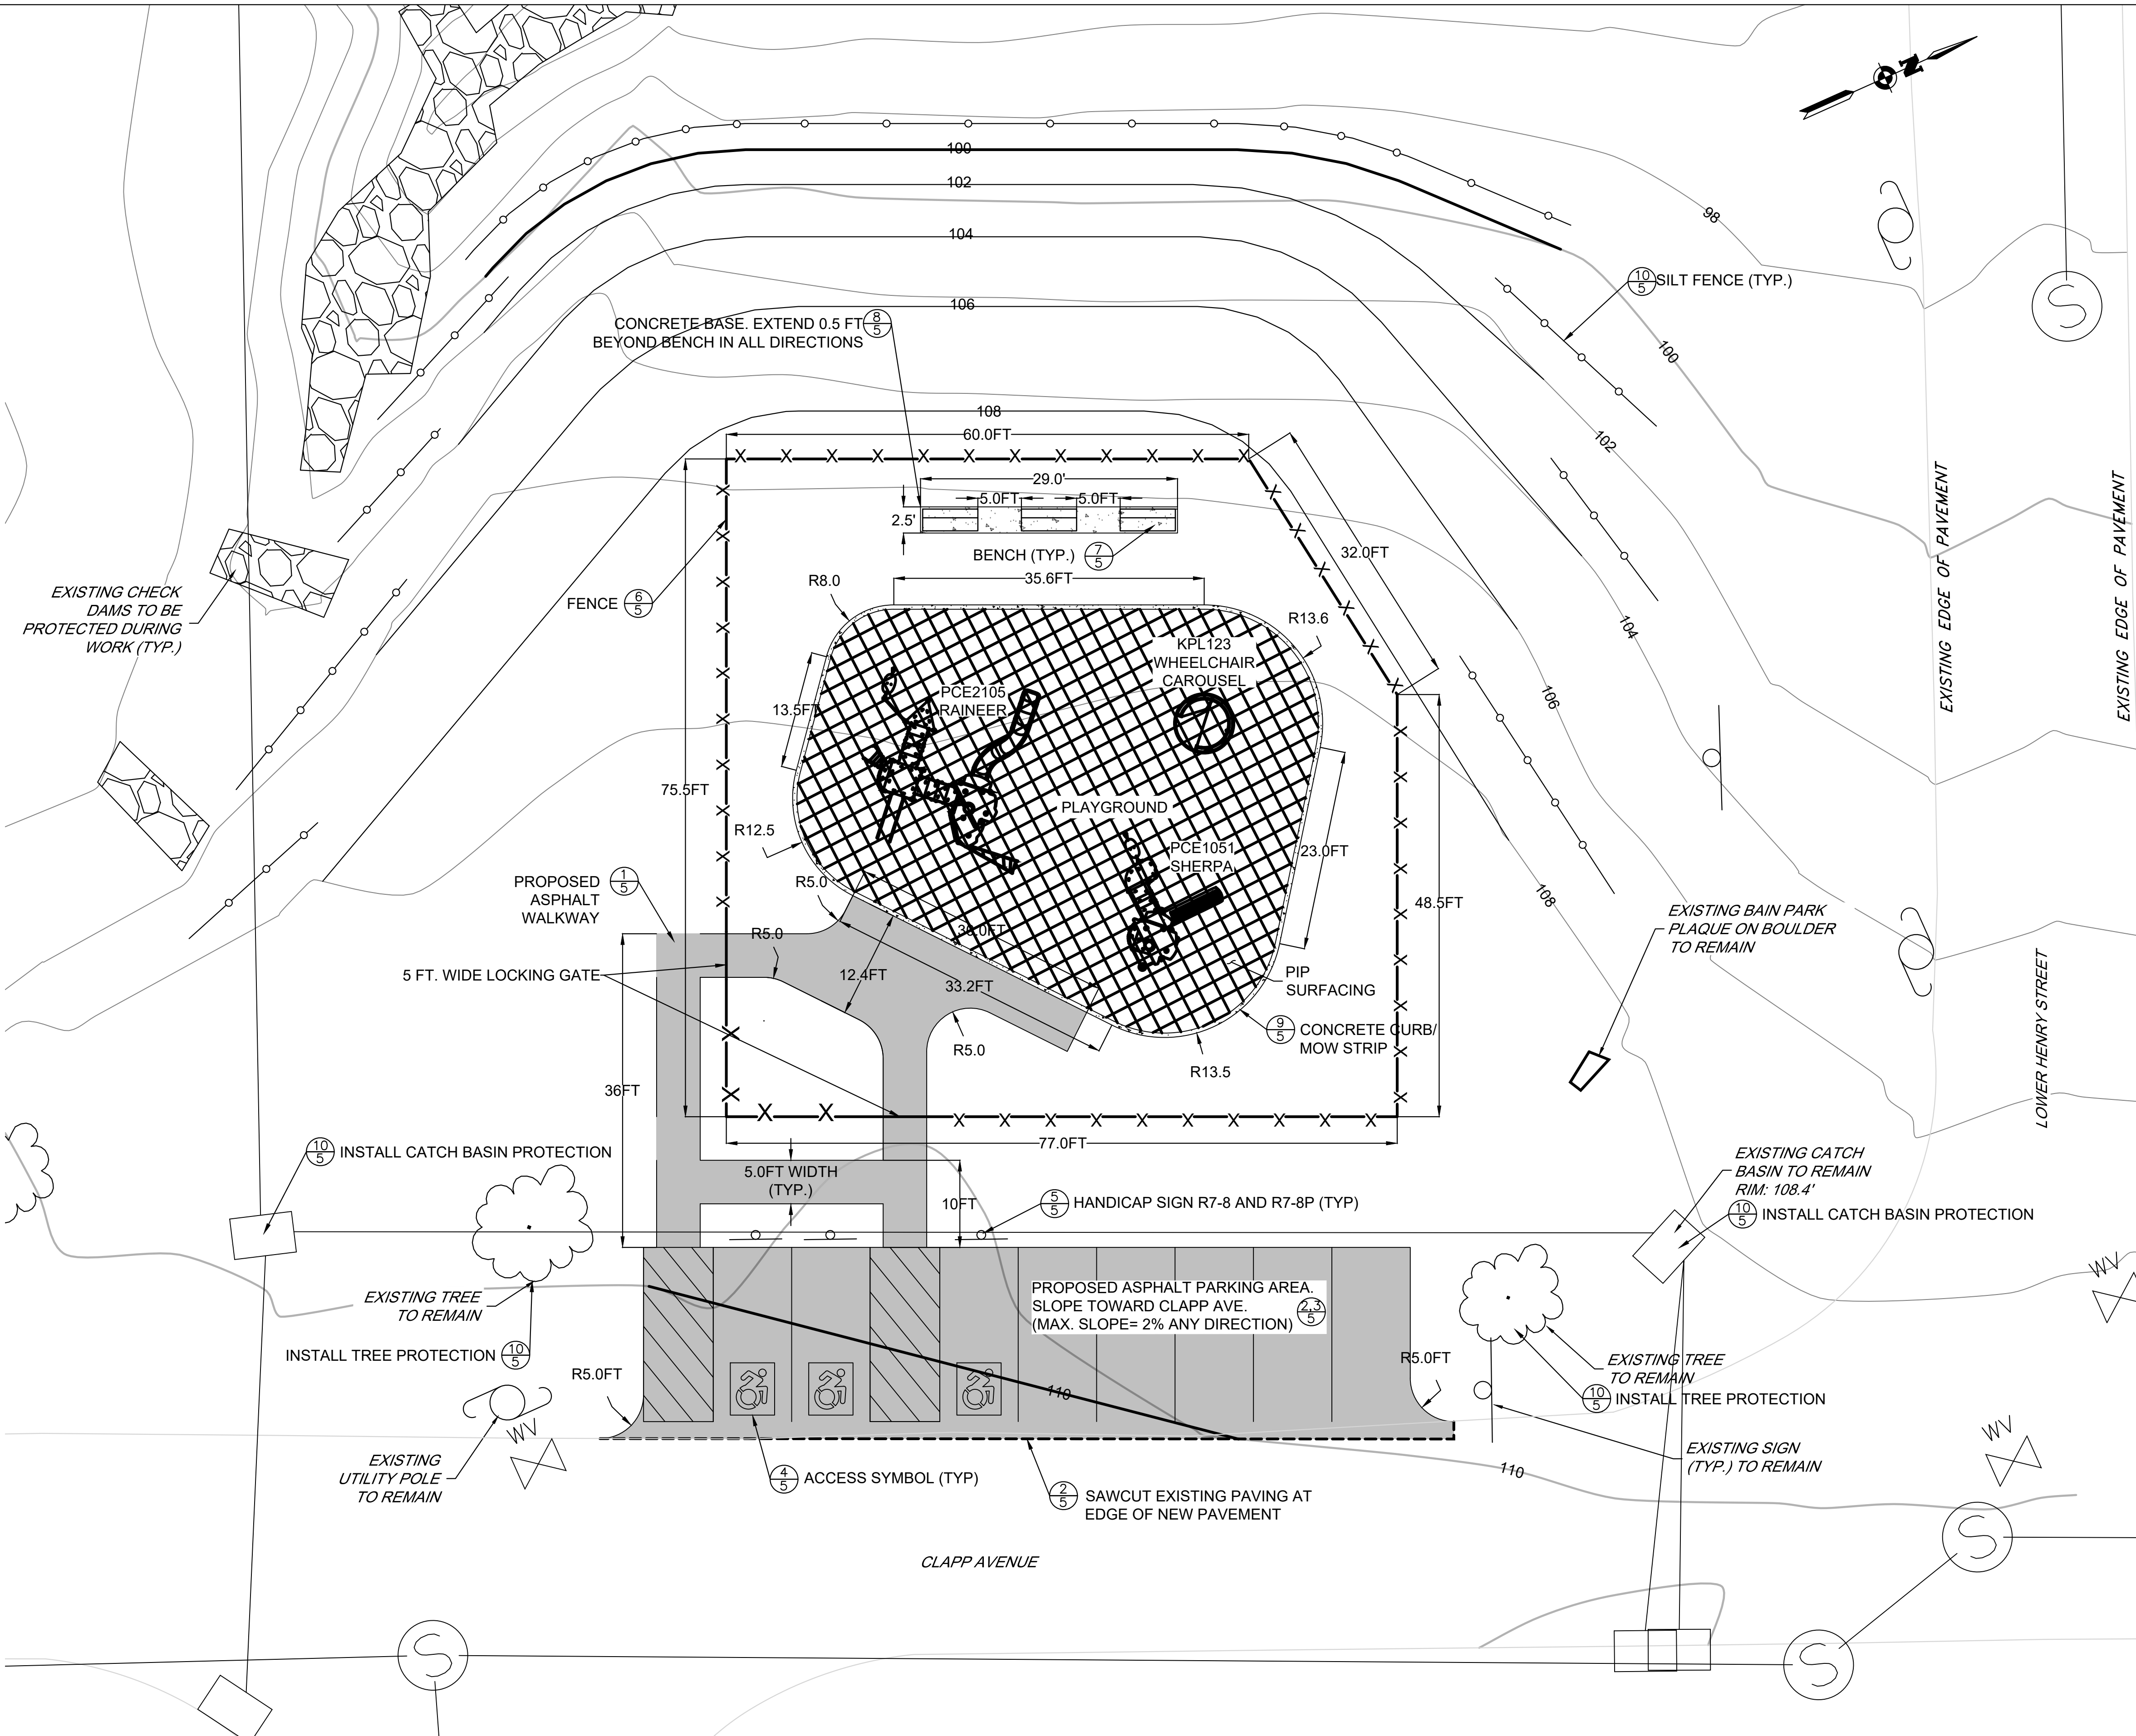

NOTES:

1. THE OWNER HAS PURCHASED AND STORED THREE BENCHES AND THE PLAYGROUND EQUIPMENT. CONTRACTOR SHALL MOVE THE PLAYGROUND EQUIPMENT FROM THE STORAGE LOCATION AND INSTALL PER OWNER'S DIRECTION IN ACCORDANCE WITH THE MANUFACTURER DIRECTIONS.
2. CONTRACTOR SHALL INSTALL POURED-IN-PLACE (PIP) MATERIALS IN ACCORDANCE WITH MANUFACTURER REQUIREMENTS.
3. CONTRACTOR SHALL PROVIDE NEAT SAWCUT LINE WHERE PROPOSED ASPHALT MEETS EXISTING ASPHALT. THE JOINT SHALL BE SEALED WITH AN APPROVED ASPHALT SEALER.
4. CONTRACTOR SHALL MAINTAIN AND MODIFY ALL EROSION & SEDIMENT CONTROL, TREE PROTECTION, AND UTILITY PROTECTION AS REQUIRED.

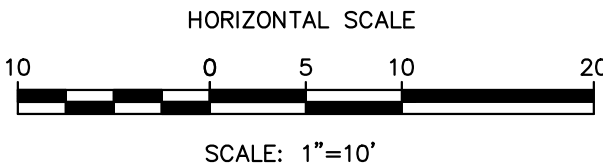

# BAIN PARK PLAY EQUIPMENT AREA PROPOSED CONDITIONS

# BRAIN PARK PLAY EQUIPMENT AREA PROPOSED CONDITIONS BID DOCUMENTS COMMUNITY DEVELOPMENT BLOCK GRANT PROJECT

INTERSECTION OF CLAPP AVENUE AND LOWER HENRY STREET  
TAX PARCEL NUMBER: 135601-6158-17-217093-0000

VILLAGE OF WAPPINGERS FALLS

DUTCHESS COUNTY

NEW YORK




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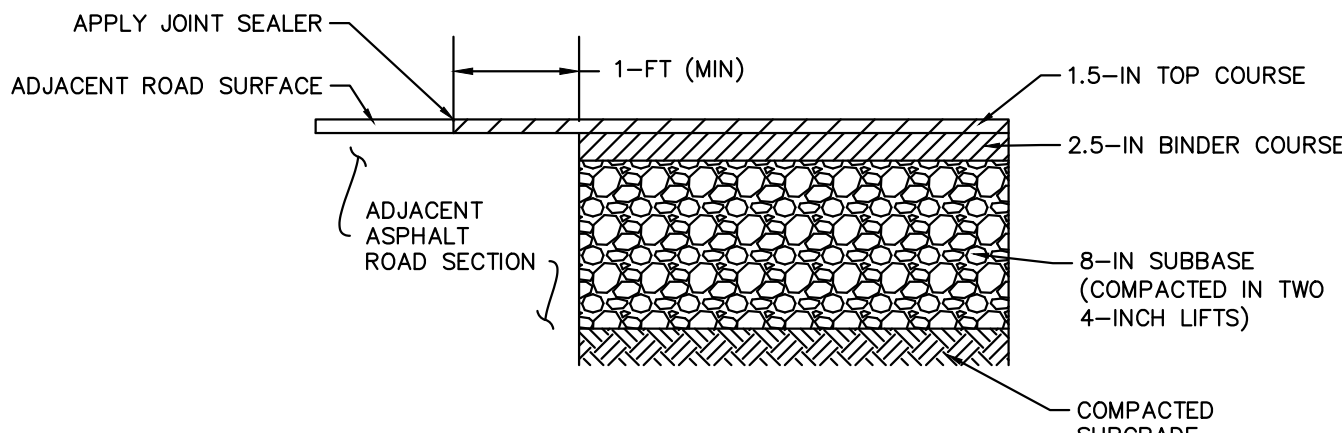
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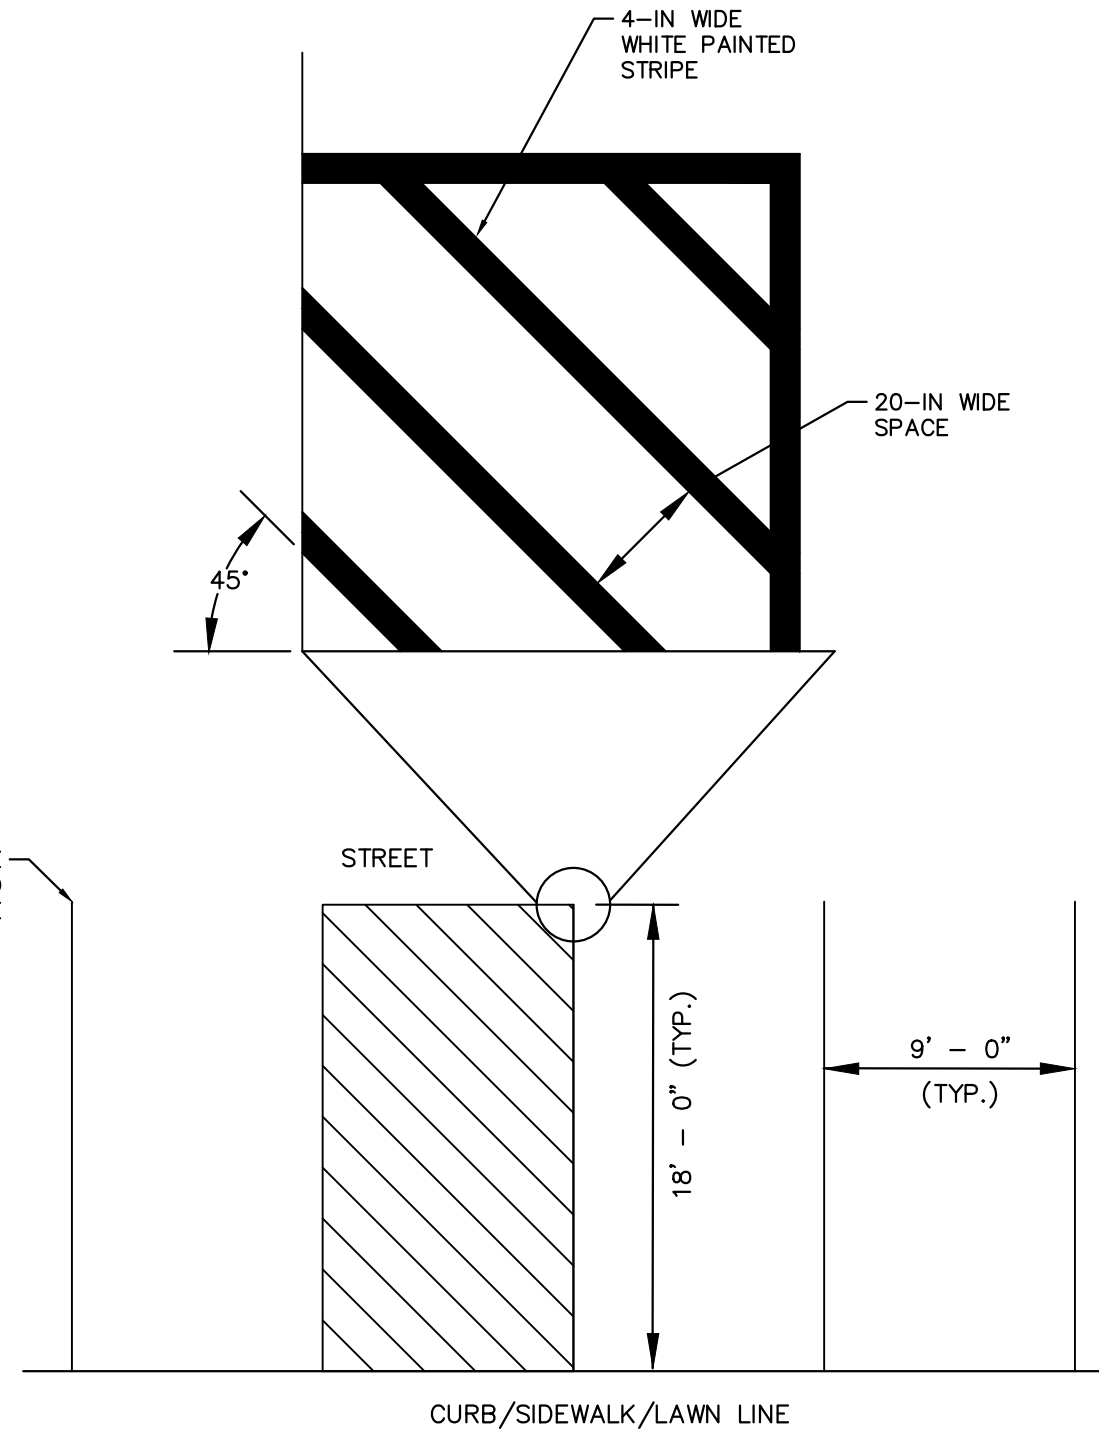
① TYPICAL ASPHALT WALKWAY  
DETAIL  
N.T.S.




NOTES:

1. ALL DEPTHS ARE COMPACTED THICKNESS.
2. MAXIMUM LIFT THICKNESS= 6 INCHES.
3. ALL MATERIALS SHALL BE AS SPECIFIED OR APPROVED EQUAL.
4. MATERIALS AND METHODS OF CONSTRUCTION SHALL BE IN CONFORMANCE WITH THE NEW YORK STATE DEPARTMENT OF TRANSPORTATION (NYSOT) STANDARD SPECIFICATIONS FOR CONSTRUCTION AND MATERIALS, DATED "CURRENT VERSION" AND ALL ADDENDA THERE TO.
5. WHEN SPECIFIED OR REQUIRED BY THE REFERENCED SPECIFICATIONS, TACK COAT SHALL CONFORM WITH SECTION 407-TACK COAT OF THE ABOVE REFERENCED NYSOT STANDARD SPECIFICATION.
6. BINDER COURSE SHALL BE SWEPT CLEAR TO REMOVE ANY LOOSE MATERIAL PRIOR TO PLACING TOP COAT. IF TOP COURSE IS NOT PLACED WITHIN TWENTY FOUR HOURS OF BINDER PLACEMENT, A TACK COAT SHALL BE APPLIED TO CLEAN SURFACE PRIOR TO PLACEMENT OF TOP COURSE.


② STANDARD DUTY ASPHALT PAVEMENT SECTION  
WITH OVERLAY  
N.T.S.

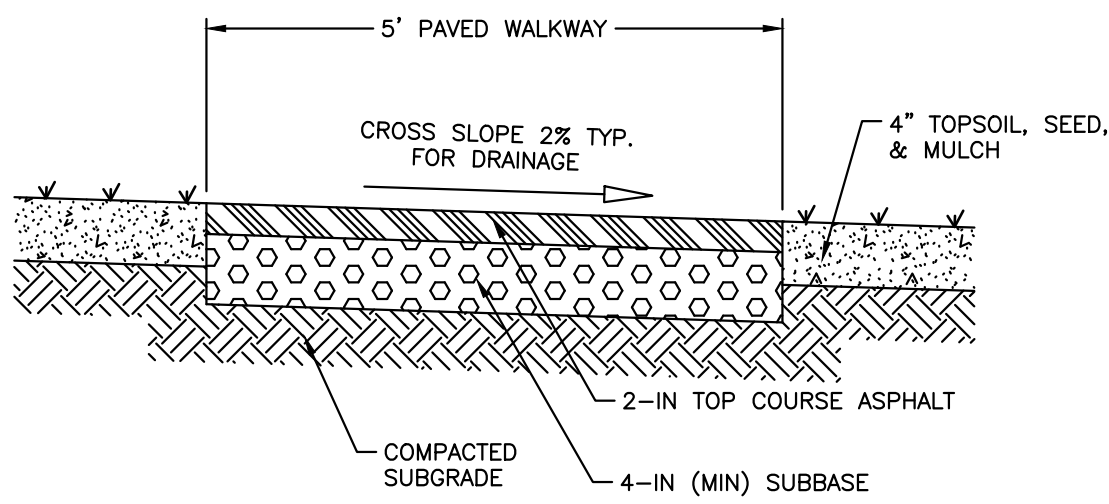

③ TYPICAL PARKING PAVEMENT MARKING LAYOUT  
N.T.S.

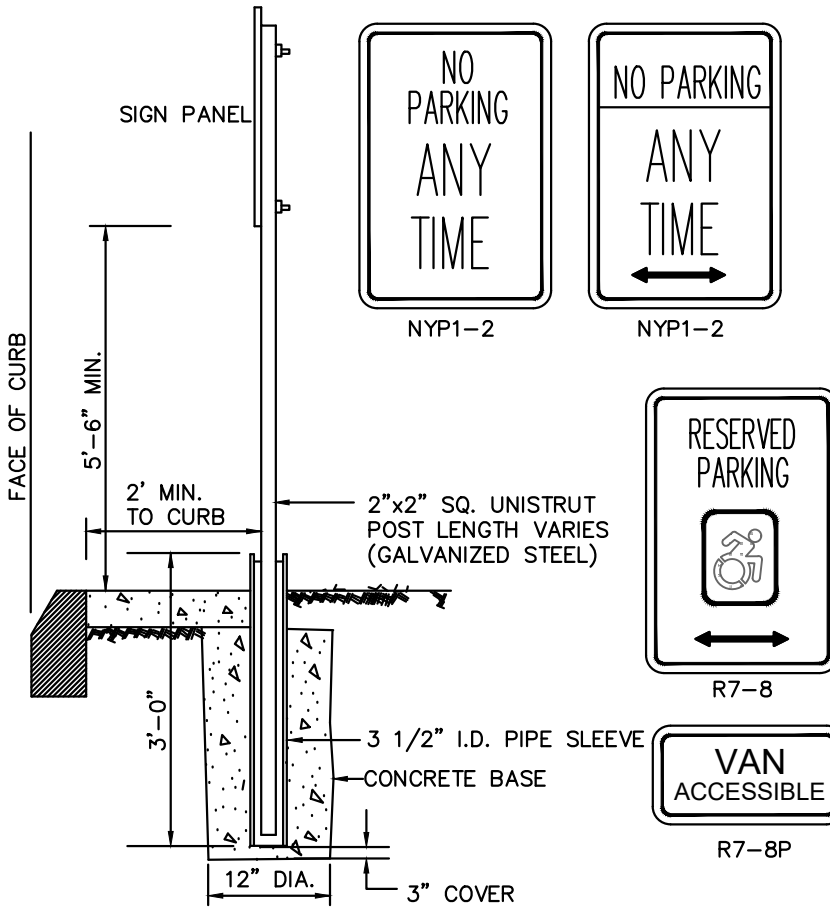


⑤ TYPICAL POST MOUNT  
HANDICAP SIGN INSTALLATION  
N.T.S.

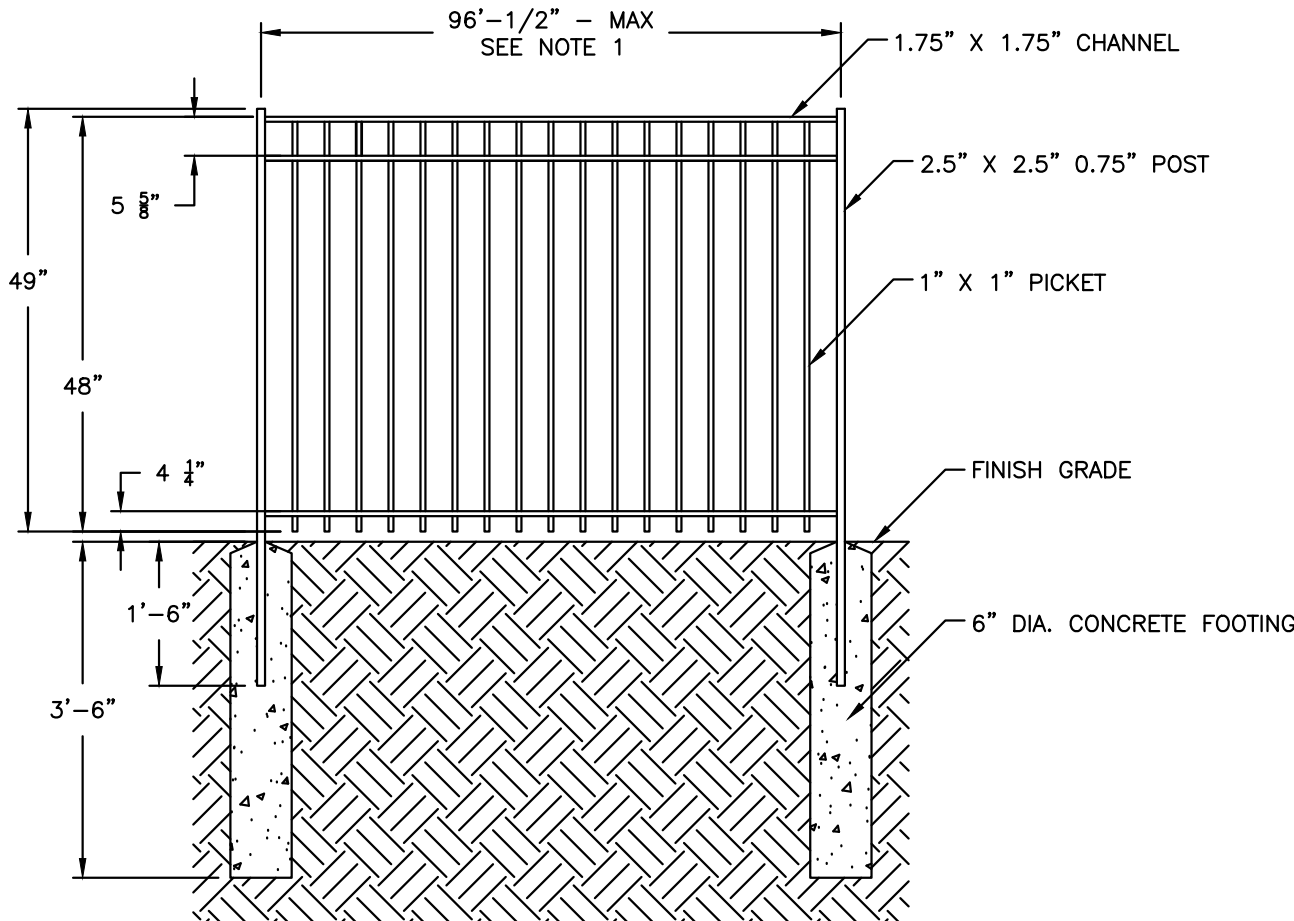


NOTES:

1. PROVIDE UNIFORM SHORT LENGTHS FOR TRANSITIONS AT ANGLES AND GATES.
2. FENCE LOCATION TO BE STAKED FOR ENGINEER'S APPROVAL PRIOR TO FINAL PLACEMENT.

⑥ ALUMINUM FENCE DETAIL  
N.T.S.

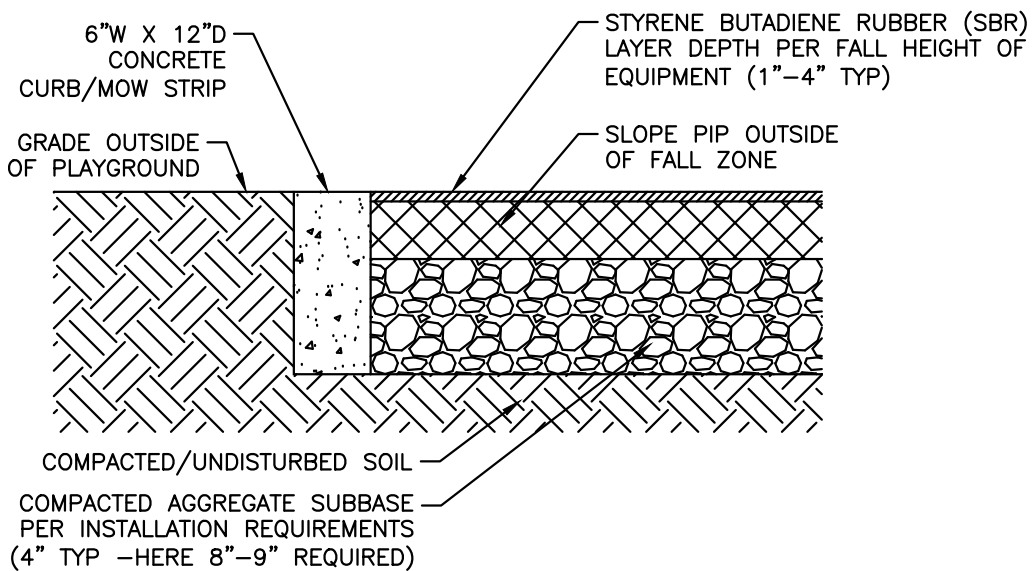


⑨ CONCRETE CURB/MOW STRIP DETAIL  
N.T.S.

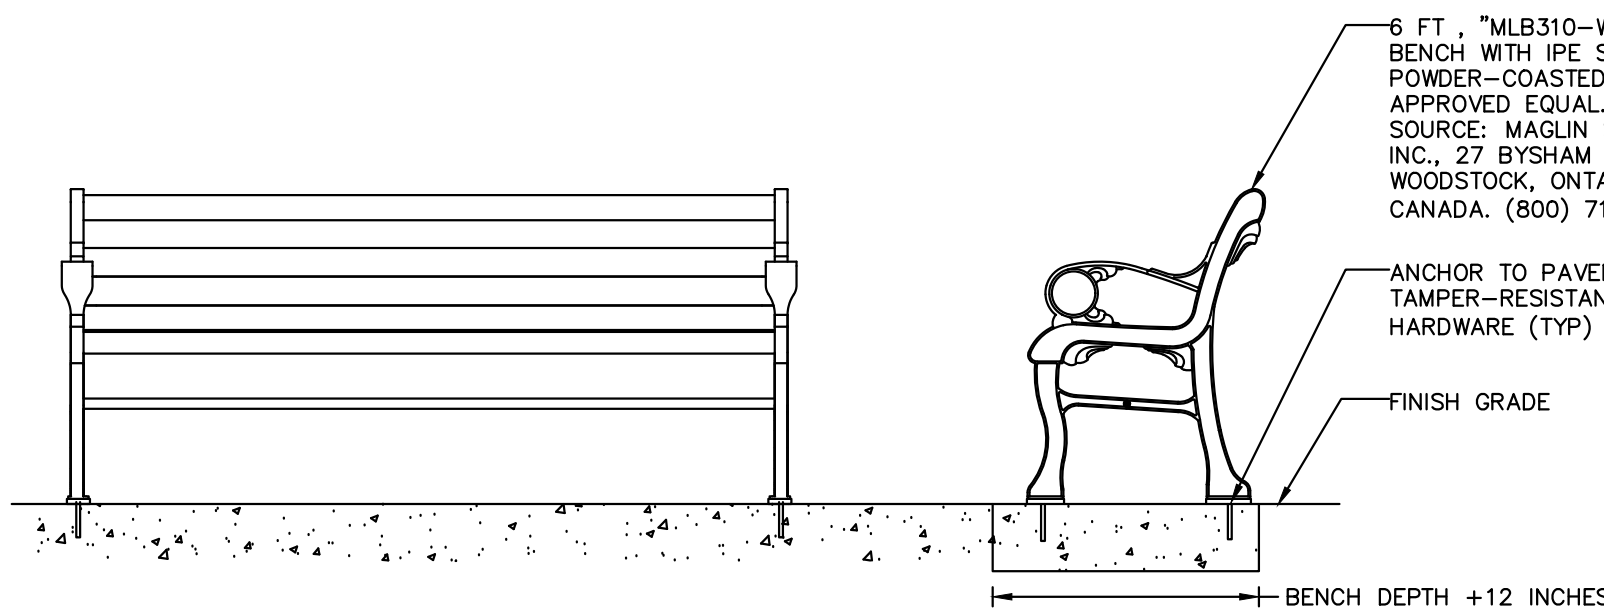


NOTE:  
THIS BENCH MATCHES BENCHES SPECIFIED AND PURCHASED FOR FRANNY REESE PARK IN THE VILLAGE OF WAPPINGERS FALLS.

⑦ BENCH DETAIL  
N.T.S.

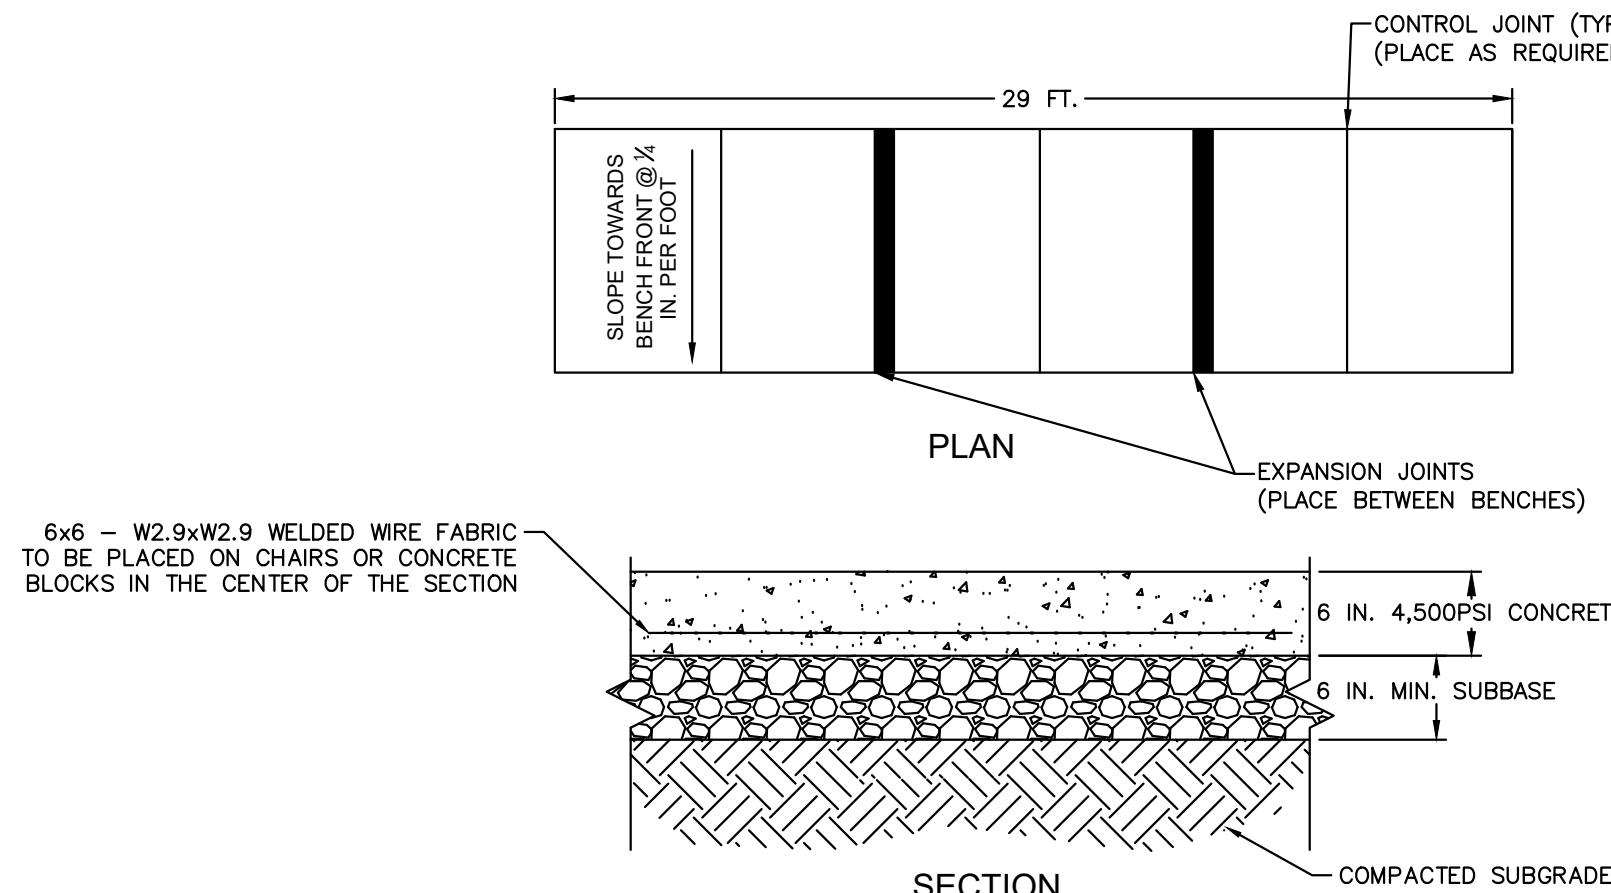


⑧ BENCH CONCRETE BASE  
DETAIL  
N.T.S.

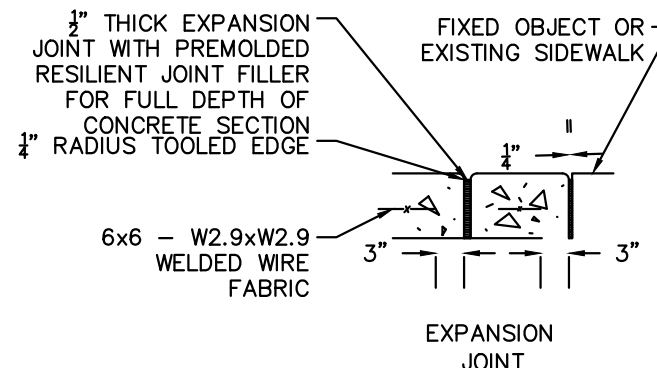

CONTRACTION  
JOINT

CONSTRUCTION  
JOINT


CONSTRUCTION  
JOINT

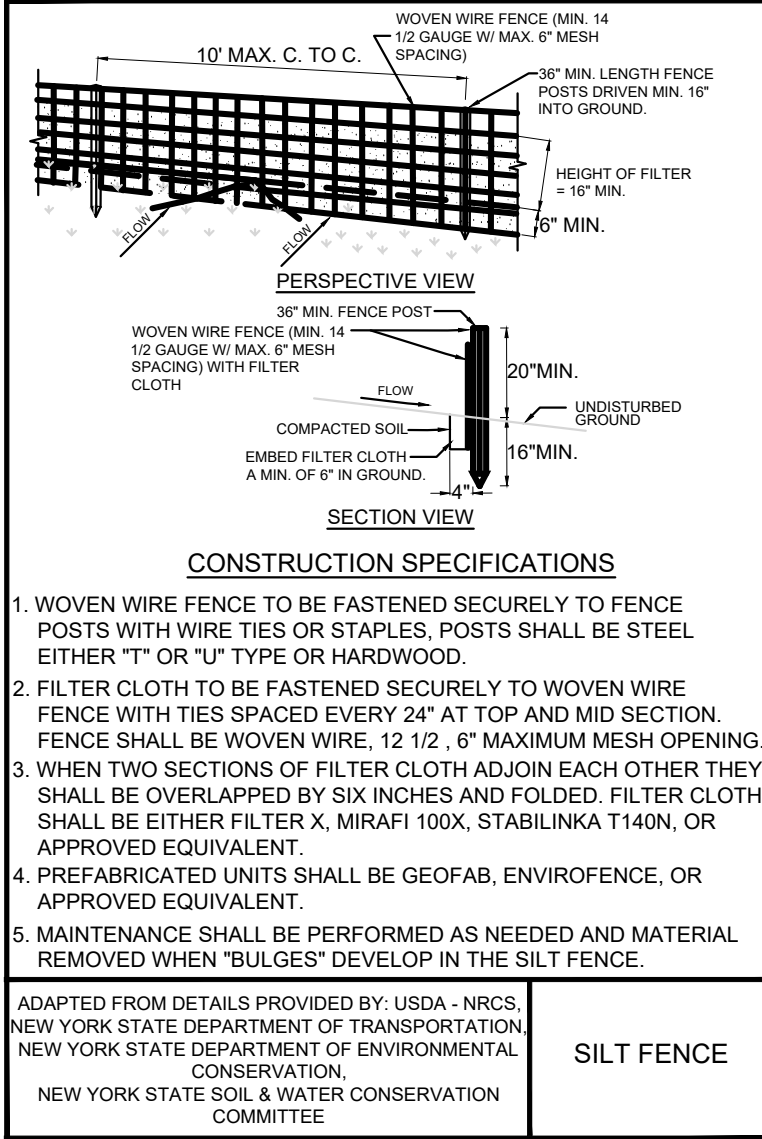

CONSTRUCTION SPECIFICATIONS

1. WOVEN WIRE FENCE TO BE FASTENED SECURELY TO FENCE POSTS WITH WIRE TIES OR STAPLES. POSTS SHALL BE STEEL EITHER "T" OR "U" TYPE OR HARDWOOD.
2. FILTER CLOTH TO BE FASTENED SECURELY TO WOVEN WIRE FENCE WITH TIES SPACED EVERY 24" AT TOP AND MID SECTION. FENCE SHALL BE WOVEN WIRE, 12 1/2, 6" MAXIMUM MESH OPENING.
3. WHEN TWO SECTIONS OF FILTER CLOTH ADJOIN EACH OTHER THEY SHALL BE OVERLAPPED BY SIX INCHES AND FOLDED. FILTER CLOTH SHALL BE EITHER FILTER X, MIRAFI 100X, STABILINKA T140N, OR APPROVED EQUIVALENT.
4. PREFABRICATED UNITS SHALL BE GEOFAB, ENVIROFENCE, OR APPROVED EQUIVALENT.
5. MAINTENANCE SHALL BE PERFORMED AS NEEDED AND MATERIAL REMOVED WHEN "BULGES" DEVELOP IN THE SILT FENCE.


ADAPTED FROM DETAILS PROVIDED BY: USDA - NRCS, NEW YORK STATE DEPARTMENT OF TRANSPORTATION, NEW YORK STATE DEPARTMENT OF ENVIRONMENTAL CONSERVATION, NEW YORK STATE SOIL & WATER CONSERVATION COMMITTEE

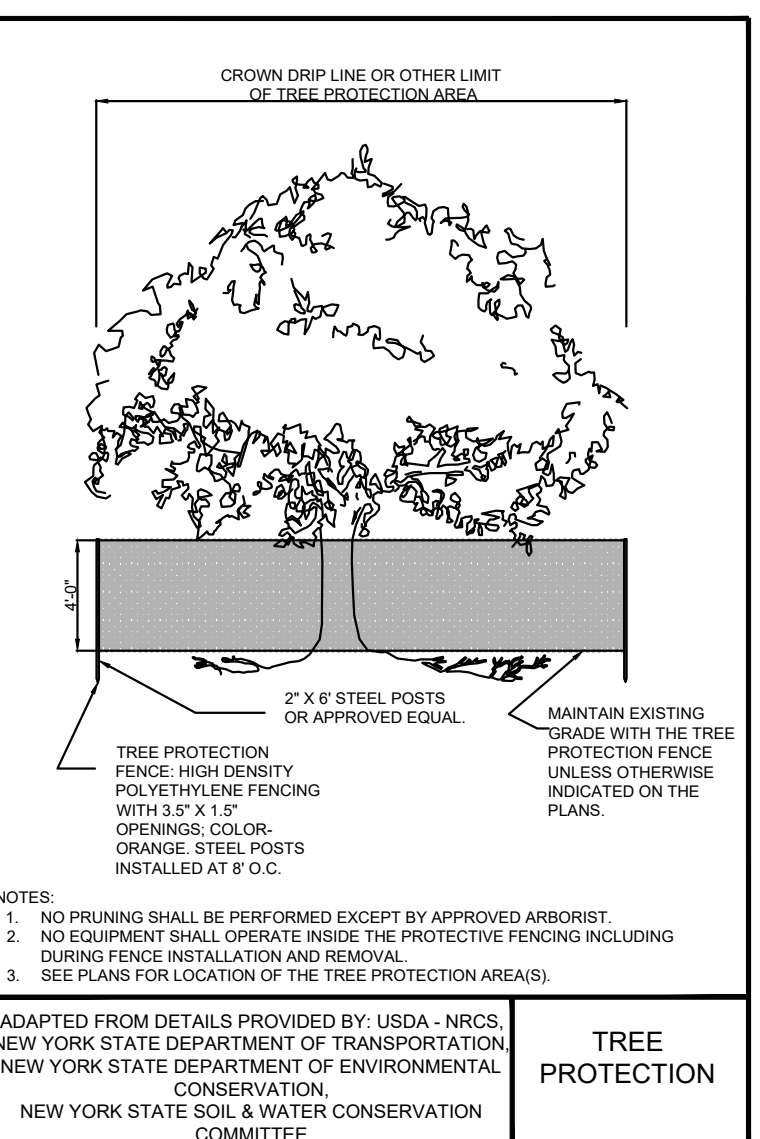

NOTES:

1. NO PRUNING SHALL BE PERFORMED EXCEPT BY APPROVED ARBORIST.
2. NO EQUIPMENT SHALL OPERATE INSIDE THE PROTECTIVE FENCING INCLUDING DURING FENCE INSTALLATION AND REMOVAL.
3. SEE PLANS FOR LOCATION OF THE TREE PROTECTION AREAS.


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CONSTRUCTION SPECIFICATIONS

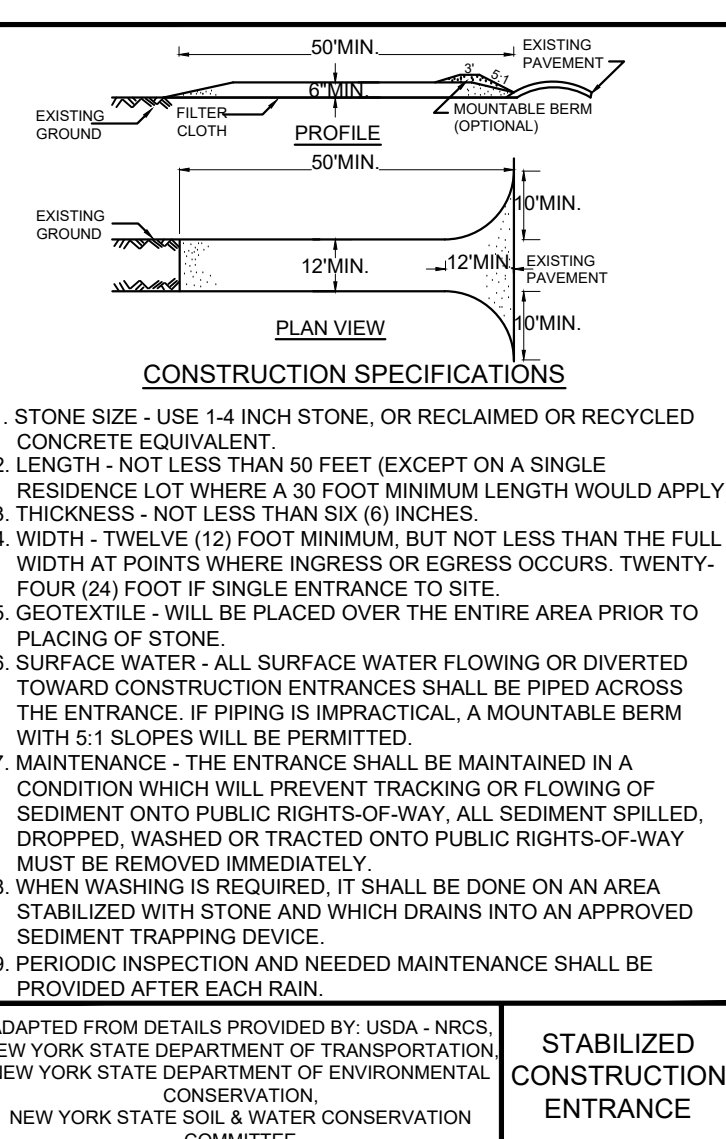1. STONE SIZE - USE 1-4 INCH STONE, OR RECLAIMED OR RECYCLED CONCRETE EQUIVALENT.
2. LENGTH - NOT LESS THAN 50 FEET (EXCEPT ON A SINGLE RESIDENCE LOT WHERE A 30 FOOT MINIMUM LENGTH WOULD APPLY).
3. THICKNESS - NOT LESS THAN SIX (6) INCHES.
4. WIDTH - TWELVE (12) FOOT MINIMUM, BUT NOT LESS THAN THE FULL WIDTH AT POINTS WHERE INGRESS OR EGRESS OCCURS. TWENTY-FOUR (24) FOOT IF SINGLE ENTRANCE TO SITE.
5. GEOTEXTILE - WILL BE PLACED OVER THE ENTIRE AREA PRIOR TO PLACING OF STONE.
6. SURFACE WATER - ALL SURFACE WATER FLOWING OR DIVERTED TOWARD CONSTRUCTION ENTRANCES SHALL BE PIPED ACROSS THE ENTRANCE. IF PIPING IS IMPRACTICAL, A MOUNTABLE BERM WITH 5:1 SLOPES WILL BE PERMITTED.
7. MAINTENANCE - THE ENTRANCE SHALL BE MAINTAINED IN A CONDITION WHICH WILL PREVENT TRACKING OR FLOWING OF SEDIMENT ONTO PUBLIC RIGHTS-OF-WAY. ALL SEDIMENT SPILLED, DROPPED, WASHED OR TRACED ONTO PUBLIC RIGHTS-OF-WAY MUST BE REMOVED IMMEDIATELY.
8. WHEN WASHING IS REQUIRED, IT SHALL BE DONE ON AN AREA STABILIZED WITH STONE AND WHICH DRAINS INTO AN APPROVED SEDIMENT TRAPPING DEVICE.
9. PERIODIC INSPECTION AND NEEDED MAINTENANCE SHALL BE PROVIDED AFTER EACH RAIN.

ADAPTED FROM DETAILS PROVIDED BY: USDA - NRCS, NEW YORK STATE DEPARTMENT OF TRANSPORTATION, NEW YORK STATE DEPARTMENT OF ENVIRONMENTAL CONSERVATION, NEW YORK STATE SOIL & WATER CONSERVATION COMMITTEE



CONSTRUCTION SPECIFICATIONS

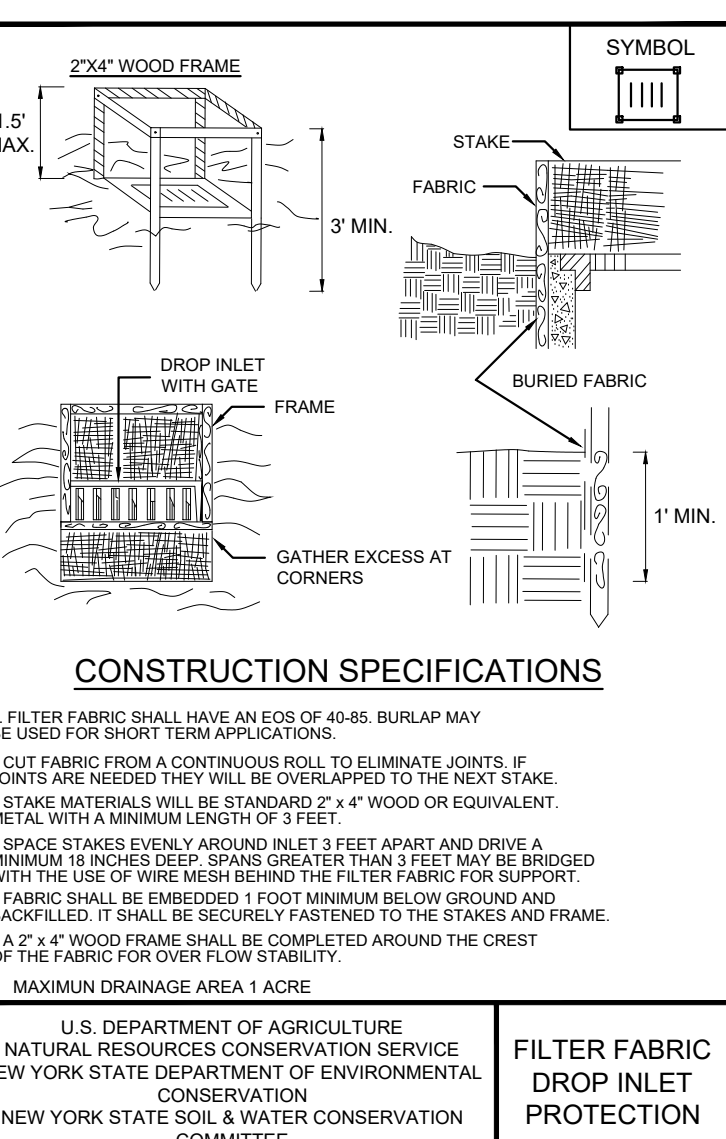1. FILTER FABRIC SHALL HAVE AN E.O.S. OF 40-85. BURLAP MAY BE USED FOR SHORT TERM APPLICATIONS.
2. CUT FABRIC FROM A CONTINUOUS ROLL TO ELIMINATE JOINTS. IF JOINTS ARE NEEDED THEY WILL BE OVERLAPPED TO THE NEXT STAKE.
3. STAKE MATERIALS WILL BE STANDARD 2" x 4" WOOD OR EQUIVALENT.
4. SPACE STAKES EVENLY AROUND INLET 3 FEET APART AND DRIVE A MINIMUM 16 INCHES MIN. SPACING GREATER THAN 3 FEET MAY BE BRIDGED WITH THE USE OF WIRE MESH BEHIND THE FILTER FABRIC FOR SUPPORT.
5. FABRIC SHALL BE BURIED 1 FOOT MINIMUM BELOW GROUND AND BACKFILLED IT SHALL BE SECURELY FASTENED TO THE STAKES AND FRAME.
6. A 2' x 4' WOOD FRAME SHALL BE COMPLETED AROUND THE CREST OF THE FABRIC FOR OVER FLOW STABILITY.

U.S. DEPARTMENT OF AGRICULTURE, NATURAL RESOURCES CONSERVATION SERVICE, NEW YORK STATE DEPARTMENT OF ENVIRONMENTAL CONSERVATION, NEW YORK STATE SOIL & WATER CONSERVATION COMMITTEE

⑩ TYPICAL NYSDEC EROSION AND  
SEDIMENT CONTROL DETAILS  
N.T.S.

BAIN PARK PLAY EQUIPMENT AREA  
DETAILS  
BID DOCUMENTS  
COMMUNITY DEVELOPMENT BLOCK GRANT PROJECT  
INTERSECTION OF CLAPP AVENUE AND LOWER HENRY STREET  
TAX PARCEL NUMBER: 135601-6158-17-217093-0000

THE INFORMATION INCLUDED ON THIS GRAPHIC REPRESENTATION HAS BEEN COMPILED FROM A VARIETY OF SOURCES AND IS SUBJECT TO CHANGE WITHOUT NOTICE. THE ENGINEER HAS NOT CONDUCTED A VISUAL VERIFICATION OF THE INFORMATION. THE ENGINEER HAS NOT CONDUCTED A VISUAL VERIFICATION OF THE INFORMATION. THE ENGINEER HAS NOT CONDUCTED A VISUAL VERIFICATION OF THE INFORMATION. THE ENGINEER HAS NOT CONDUCTED A VISUAL VERIFICATION OF THE INFORMATION. THE ENGINEER HAS NOT CONDUCTED A VISUAL VERIFICATION OF THE INFORMATION. THE ENGINEER HAS NOT CONDUCTED A VISUAL VERIFICATION OF THE INFORMATION. THE ENGINEER HAS NOT CONDUCTED A VISUAL VERIFICATION OF THE INFORMATION. THE ENGINEER HAS NOT CONDUCTED A VISUAL VERIFICATION OF THE INFORMATION. THE ENGINEER HAS NOT CONDUCTED A VISUAL VERIFICATION OF THE INFORMATION. THE ENGINEER HAS NOT CONDUCTED A VISUAL VERIFICATION OF THE INFORMATION.

No.	Date	Revision

PROJECT # 23-1004	SHEET NUMBER 5
DATE: OCT. 9, 2023	
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